
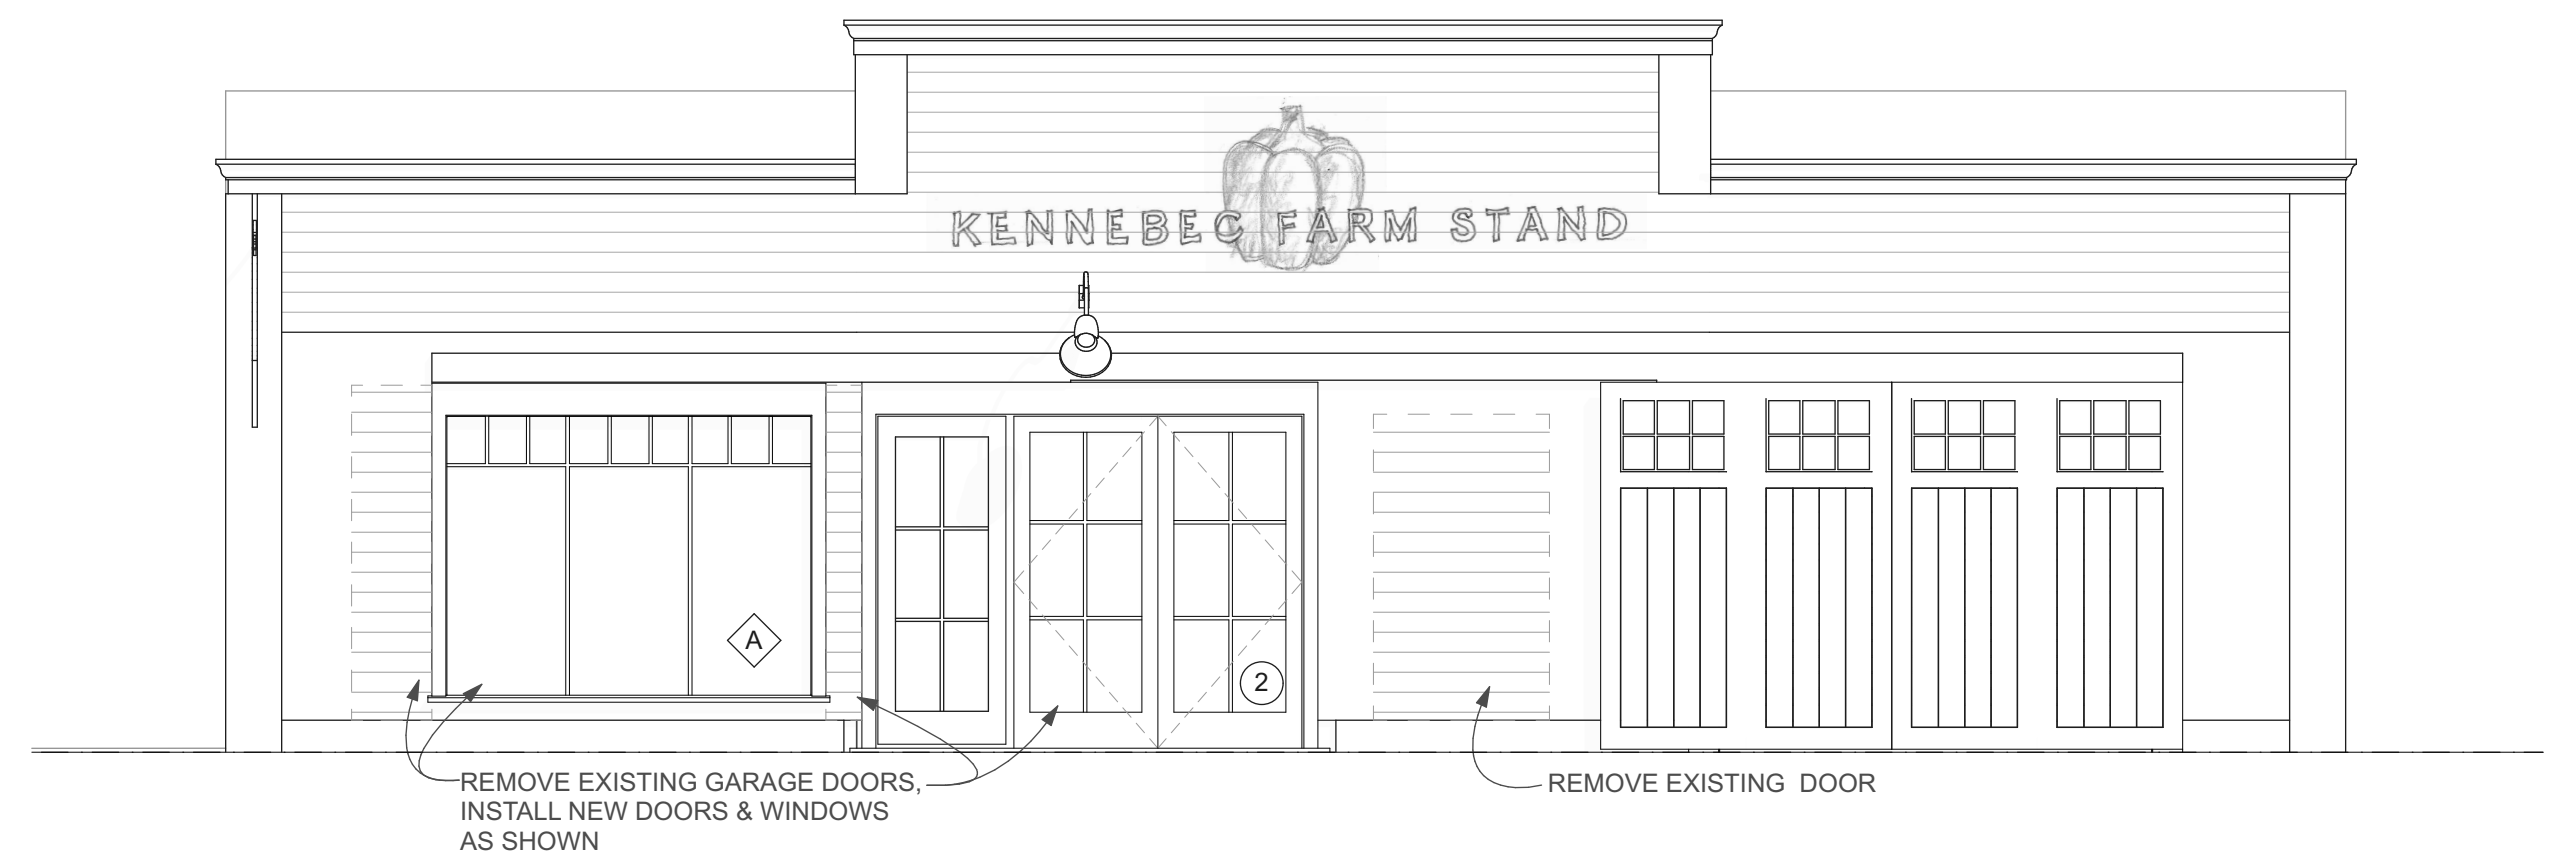


WINDOW SCHEDULE - FOR PRICING ONLY								
MARK	QUANT.	TYPE	MANUF	MODEL#	LITES	FRAME SIZE (NOT R.O.)		NOTES
						WIDTH	HEIGHT	
A	1	FIXED	LOEWEN	CUSTOM	12	7'-8"	6'-0"	


SQUARE FOOTAGE	
NAME	AREA (SQFT)
PROPOSED GENERAL STORE	922
	922 sq ft

DOOR SCHEDULE - FOR PRICING ONLY								
MARK	QUANT.	TYPE	MANUF.	MODEL#	LITES	UNIT SIZE (NOT R.O.)		NOTES
						WIDTH	HEIGHT	
1	1	FRENCH DOOR	SIMPSON	TBD	06	3'-0"	6'-9 3/4"	OUTSWING
2	1	FRENCH DOOR	LOEWEN	TBD	06	6'-0"	7'-0"	OUTSWING W/ 36" W. SIDELIGHT


Notes:
 Windows and Doors to be insulated Low-E argon-filled double-pane glass to meet or exceed energy performance U-Factor of 0.32.
 Window Manufacturer/Contractor to obtain sign-off from Architect on which units require tempered glass before placing order.
 Windows and Doors glazing are required to meet *Wind Borne Debris Region* requirements for Large Missile Test of ASTM E-1996 and of ASTM E-1886.
 Garage door glazed opening protection for windborne debris shall meet the requirements of an approved impact resisting standard or ANSI/DASMA-115.
 Wood structural panels constructed to meet code, shall be provided for all exterior glazed openings, and any existing openings as indicated on architectural plans (See detail W-02)
 Windows and Doors to meet required Design Pressures ratings for *Wind Speed, Exposure Zone, and Roof Height* listed on these drawings
 Contractor to submit Manufacturer's Design Pressures ratings for sign-off approval on all windows and doors before placing order.
 Contractor to verify quantities before placing order.
 Contractor to obtain rough openings from manufacturer for framing.
 All Windows to be _____; Color: _____ Hardware: _____
 All Terrace Doors to be _____; Color: _____ Hardware: _____
 Terrace Door Interior to be _____; Color: _____

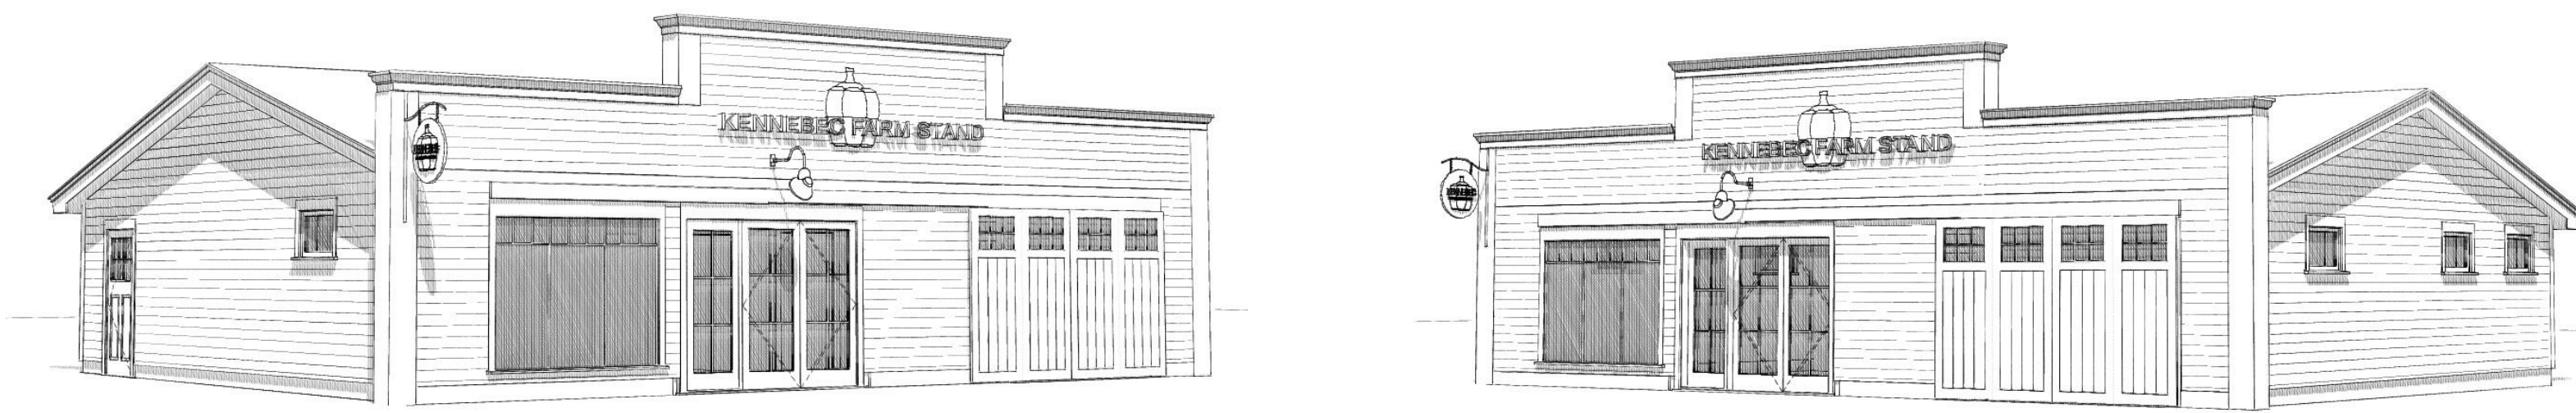


1 PROPOSED NORTH ELEVATION
 SCALE: 1/4" = 1'-0"

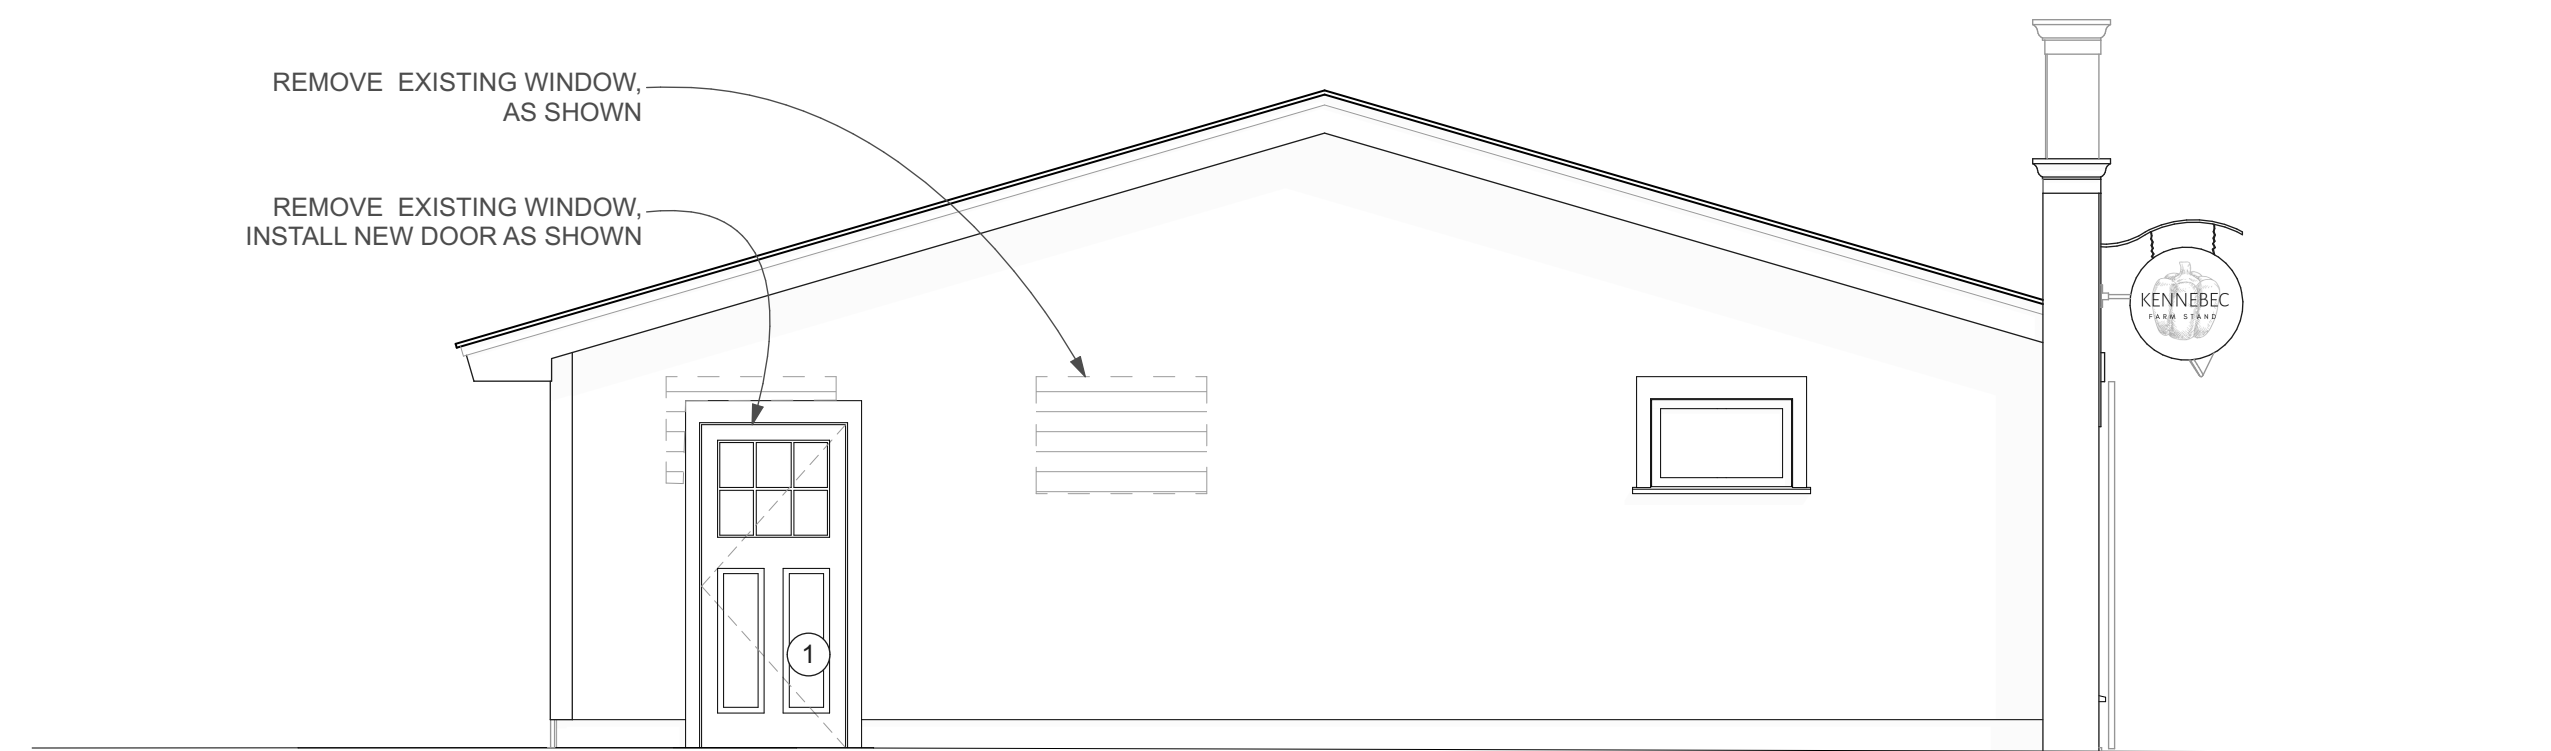


2 PROPOSED EAST ELEVATION
 SCALE: 1/4" = 1'-0"

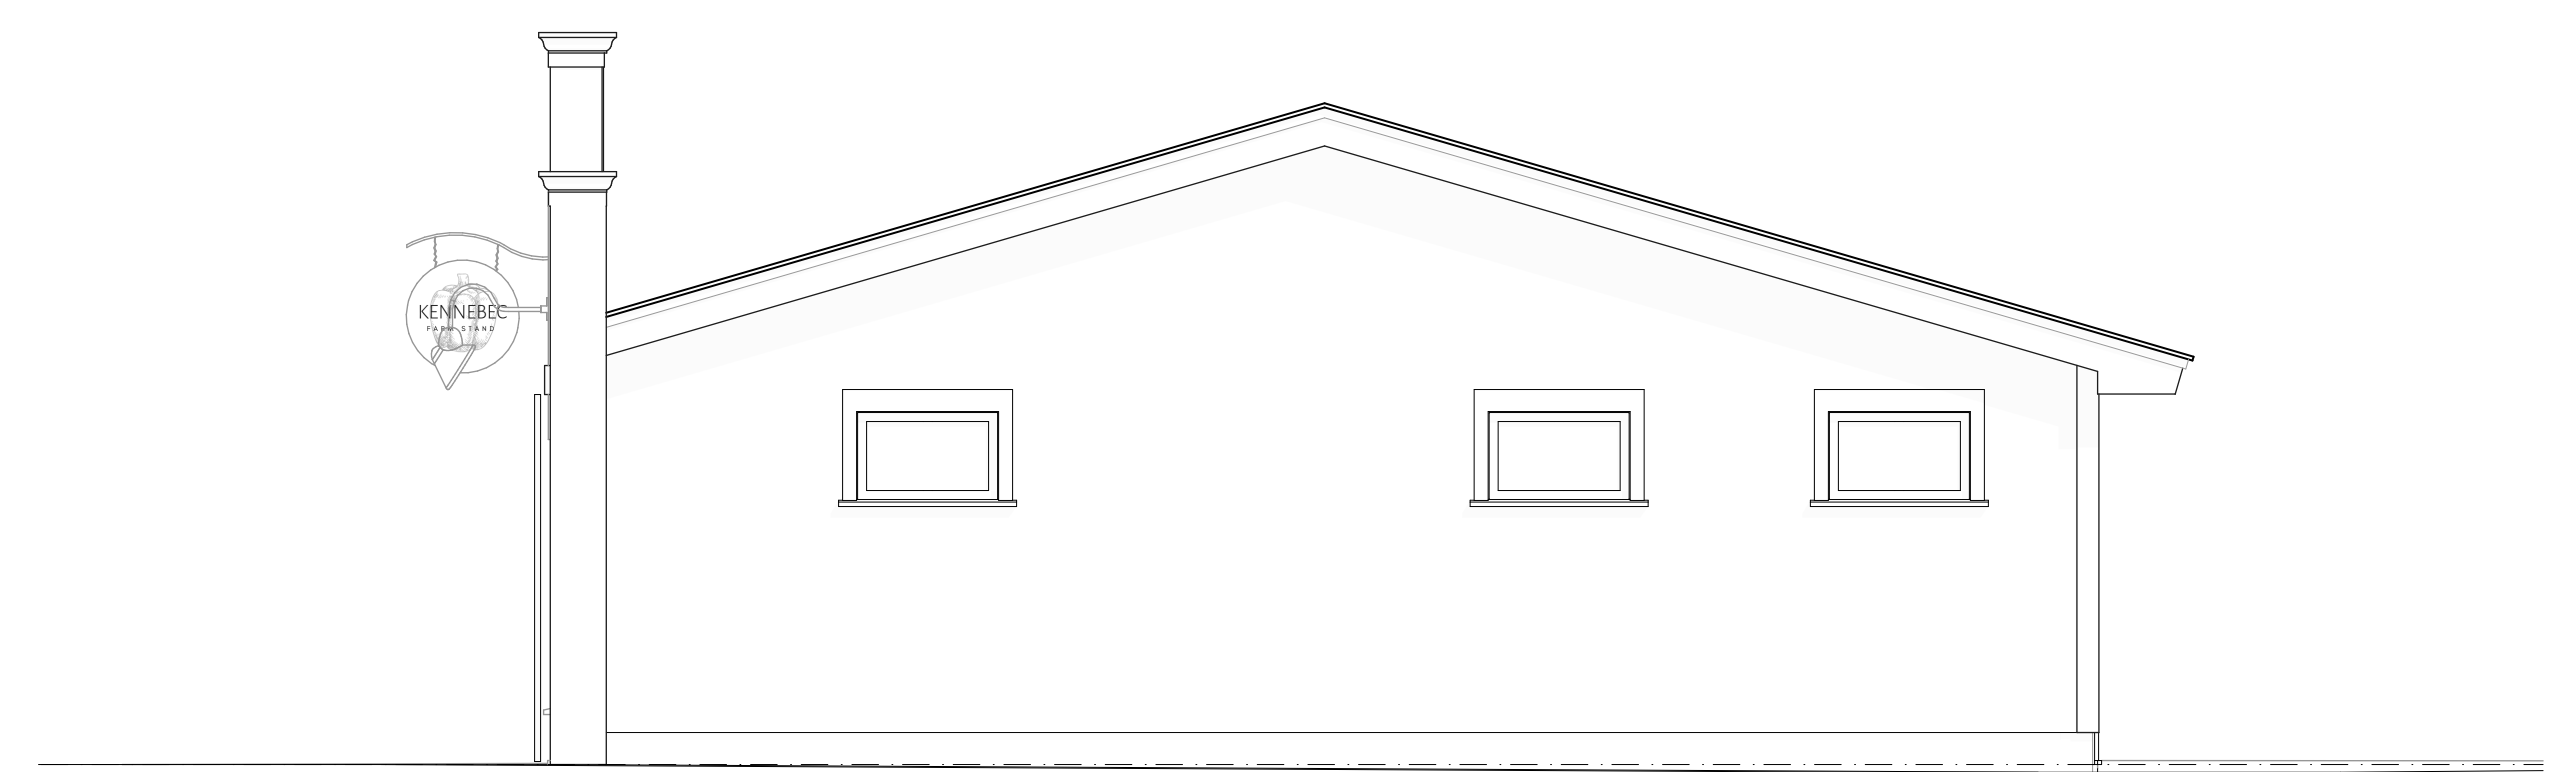

3 PROPOSED WEST ELEVATION
 SCALE: 1/4" = 1'-0"

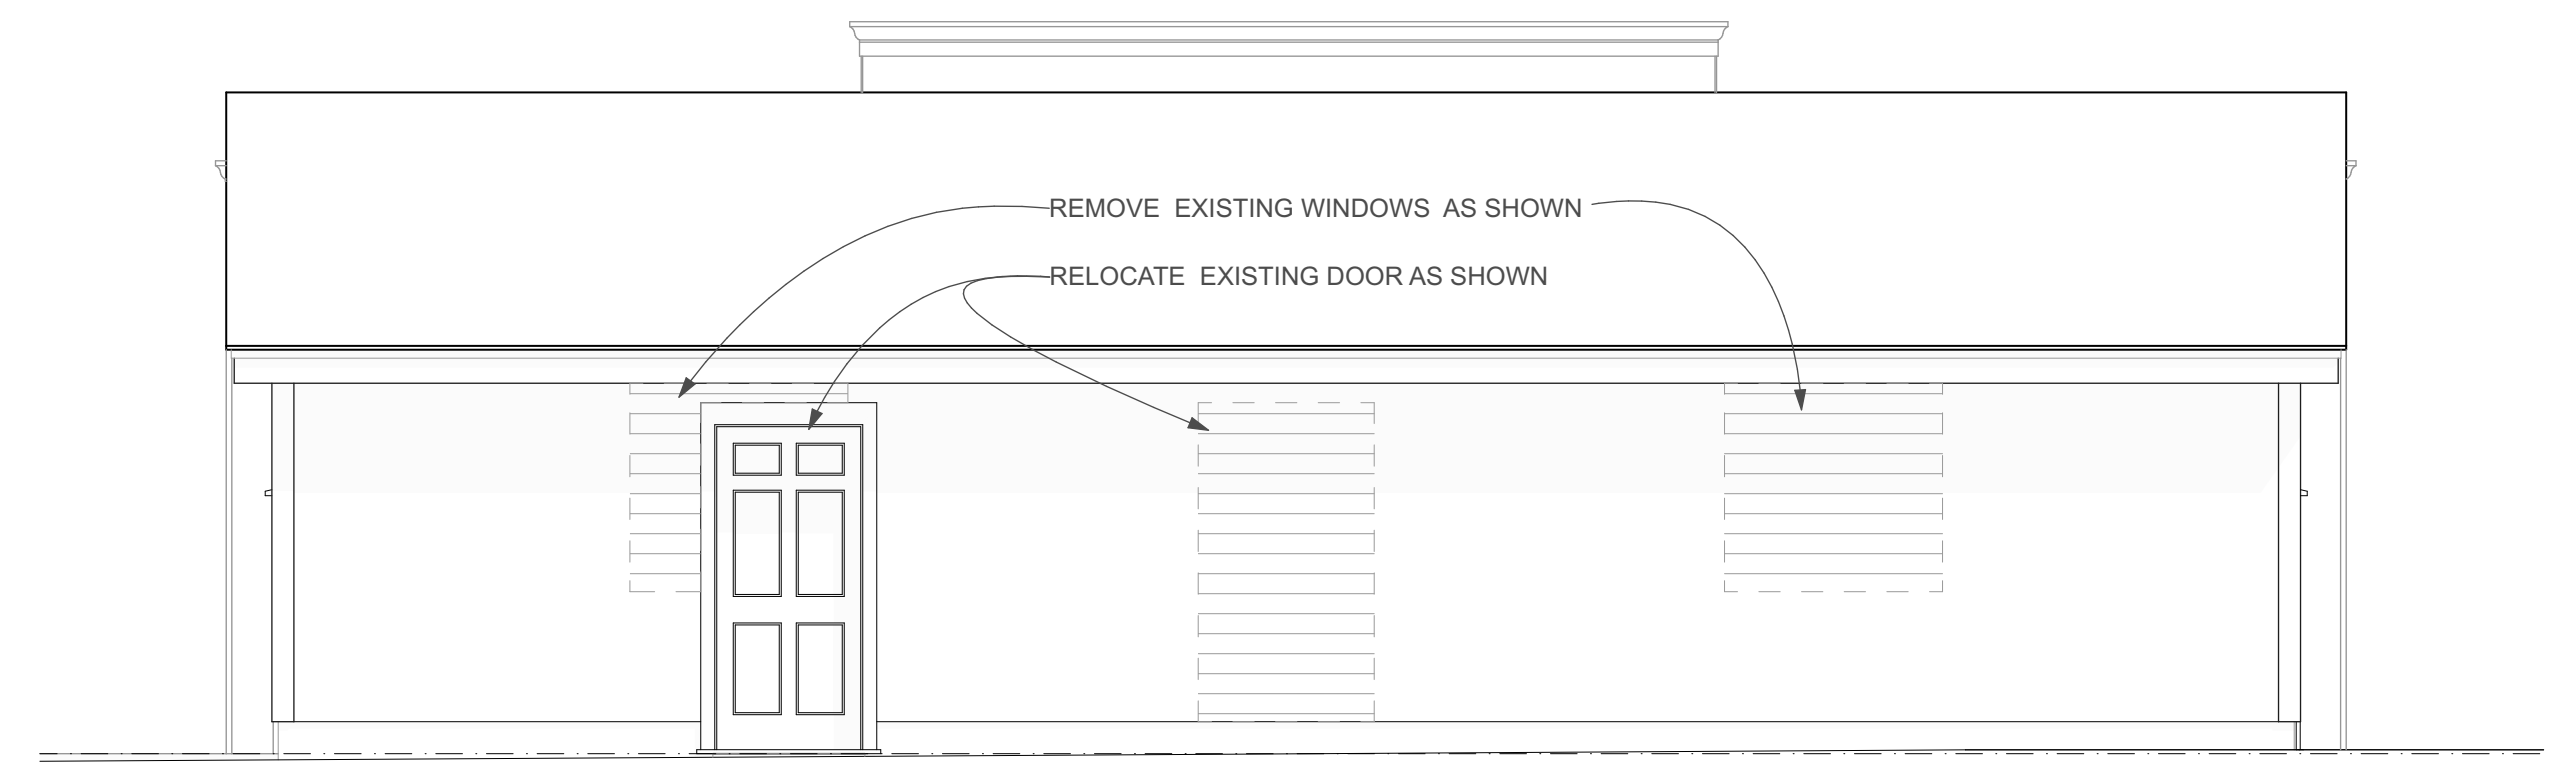


4 PROPOSED SOUTH ELEVATION
 SCALE: 1/4" = 1'-0"

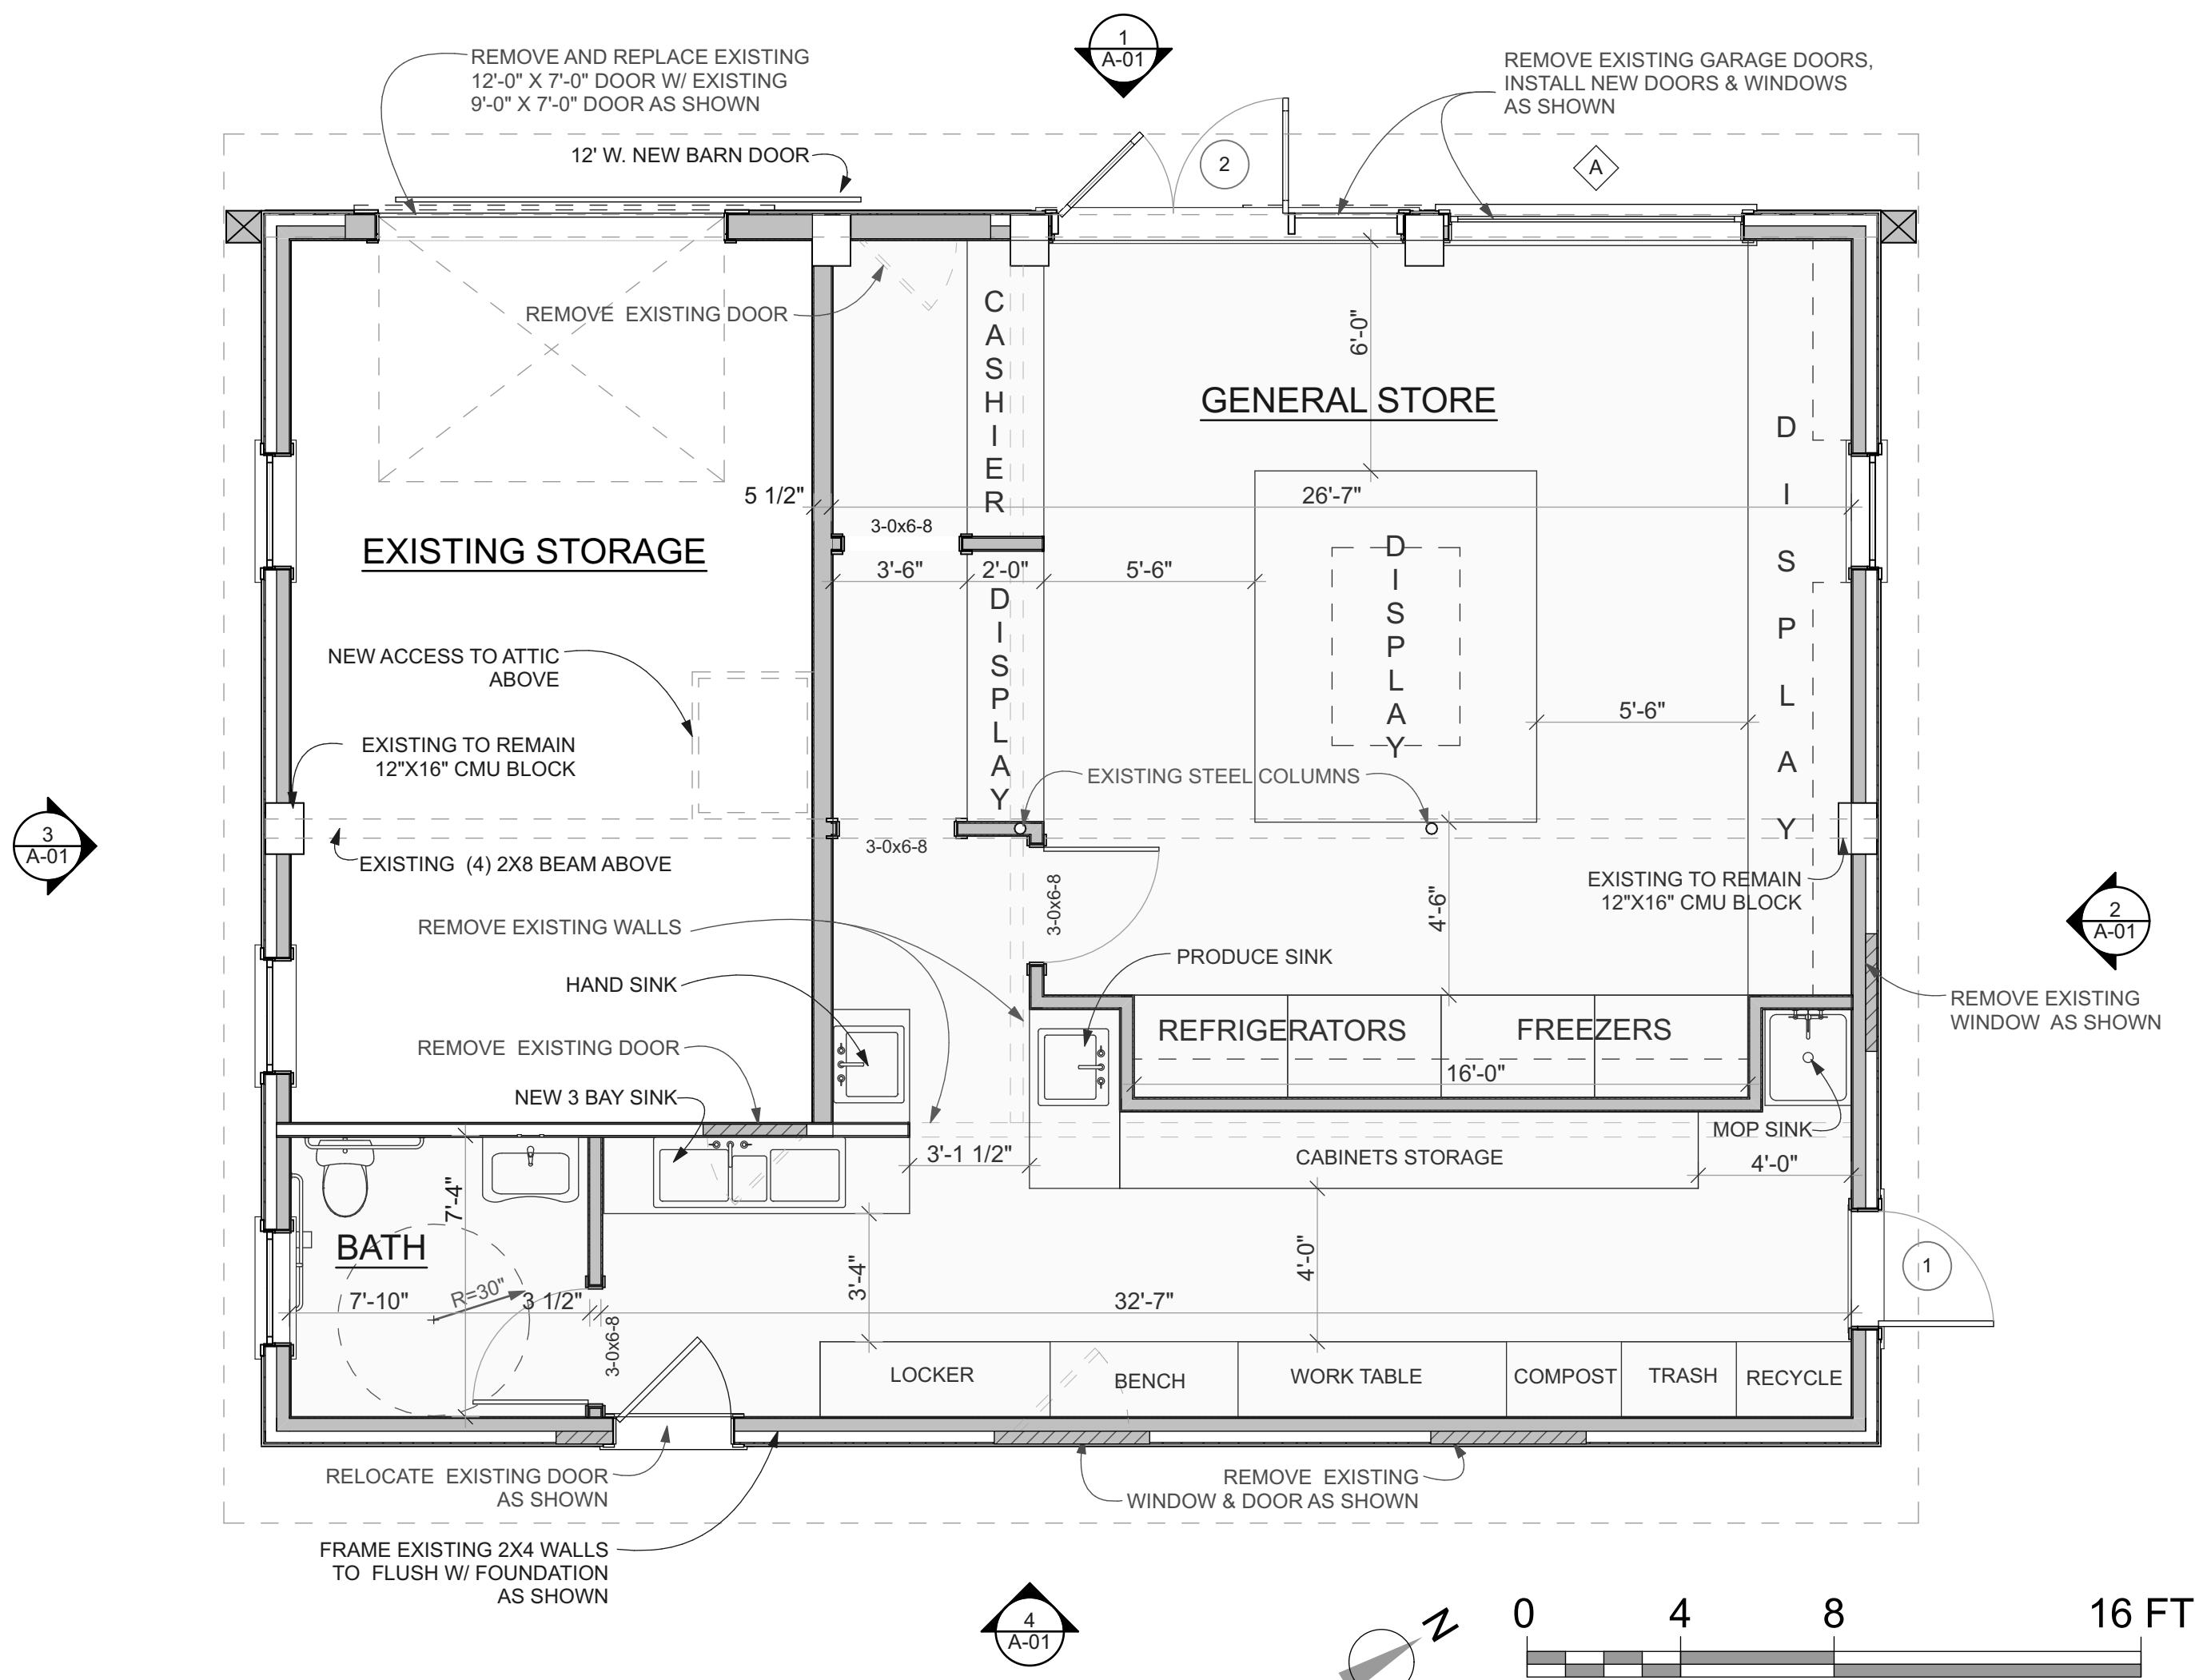

PROPOSED FIRST FLOOR PLAN

SCALE: 1/4" = 1'-0"

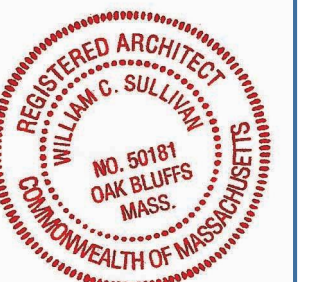

SET: DATE:

PROJECT NAME:
 ADDRESS:
 SHEET TITLE:
 DRAWN BY: MT
 DATE: 2019-02-20
 MAP/PARCEL: 9-14
 JOB #: 19K01
 DRAWING #: